




LOCUS MAP N.T.S


DMH RIM=45.02 INV=34.03 (REC) ⊚

## WHITE STREET

(40.0 FT. WIDE - PUBLIC)

BIT. CONC. ROADWAY

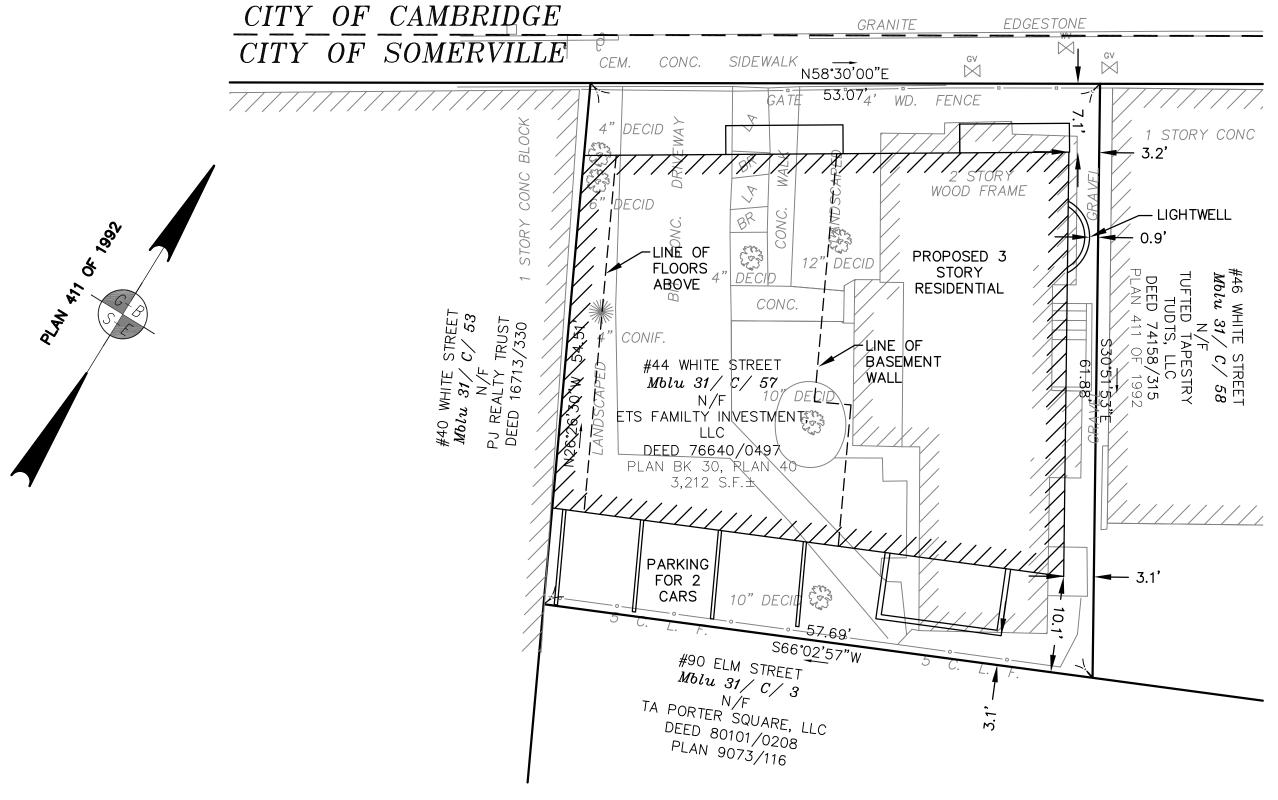

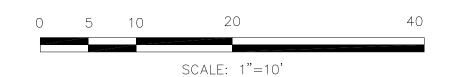



# PLAN OF PROPOSED CONSTRUCTION 44 WHITE STREET SOMERVILLE, MASSACHUSETTS

(MIDDLESEX-SOUTH REGISTY OF DEEDS)


PREPARED FOR JACOB SIMMONS




GREATER BOSTON SURVEYING AND ENGINEERING


19 FREDITH ROAD
WEYMOUTH, MA 02189
(781) 331-6128

CALC BY: PJT DATE:MAY 30, 2024 SCALE: 1"=10'

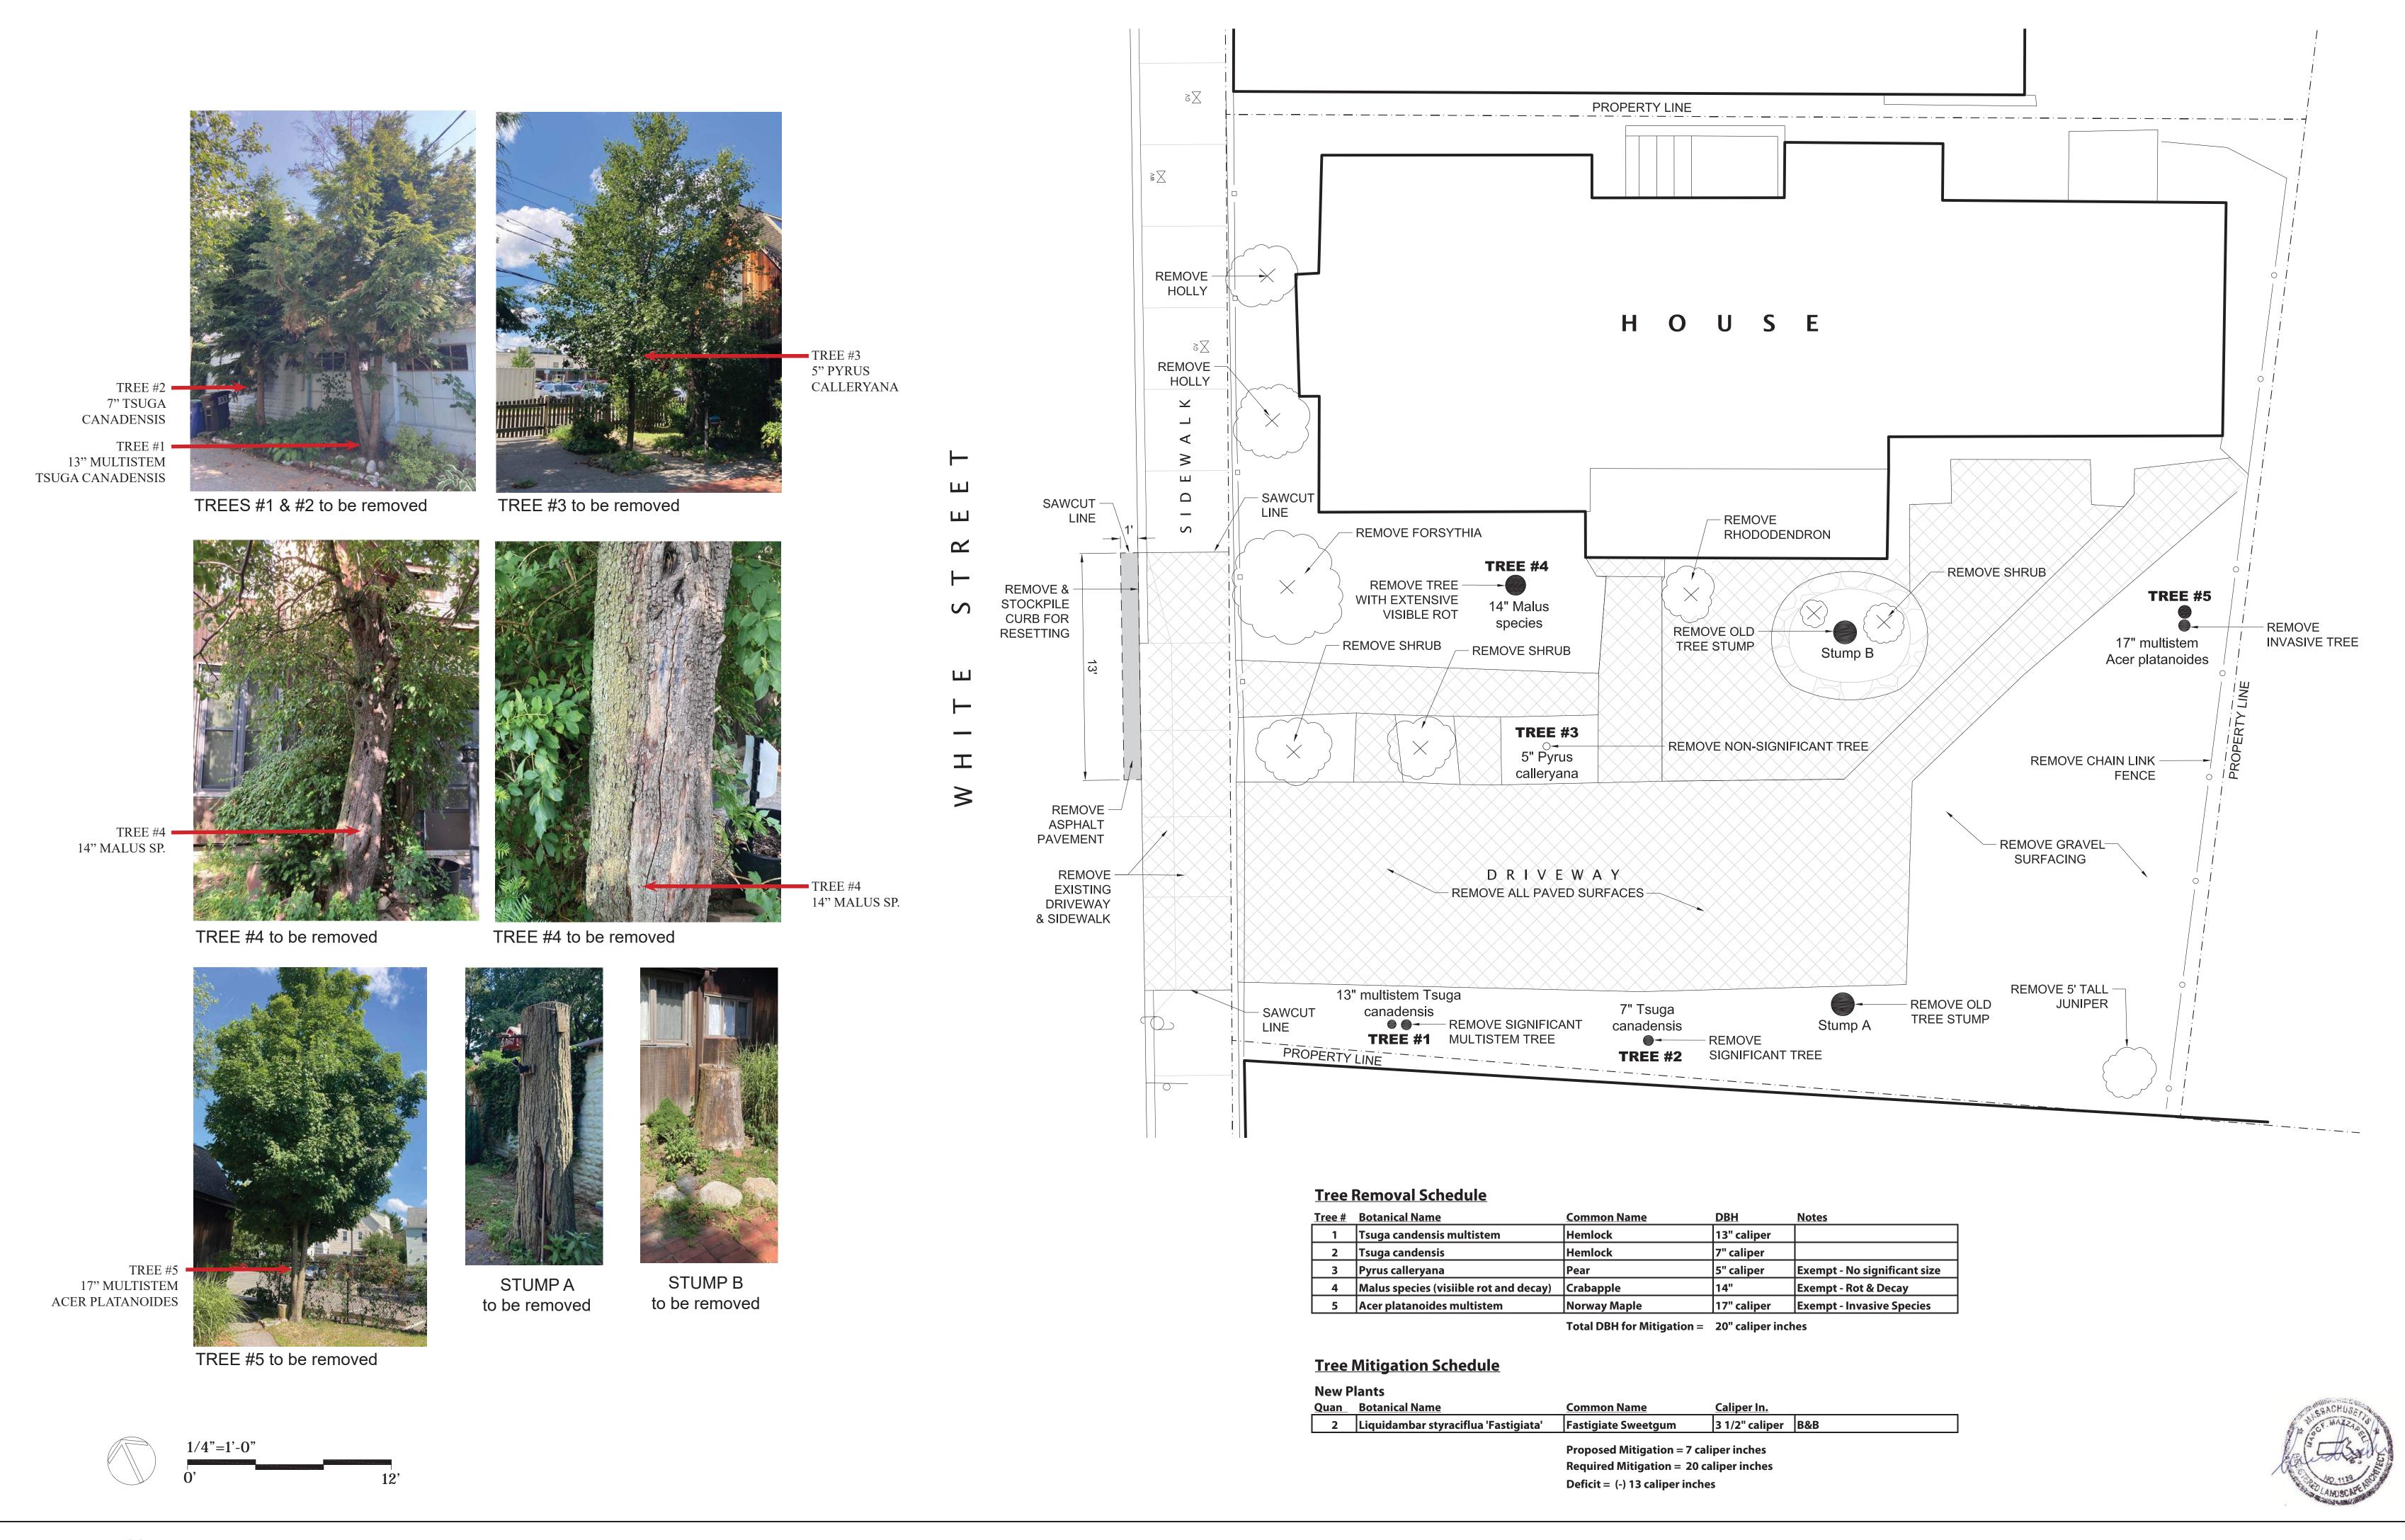



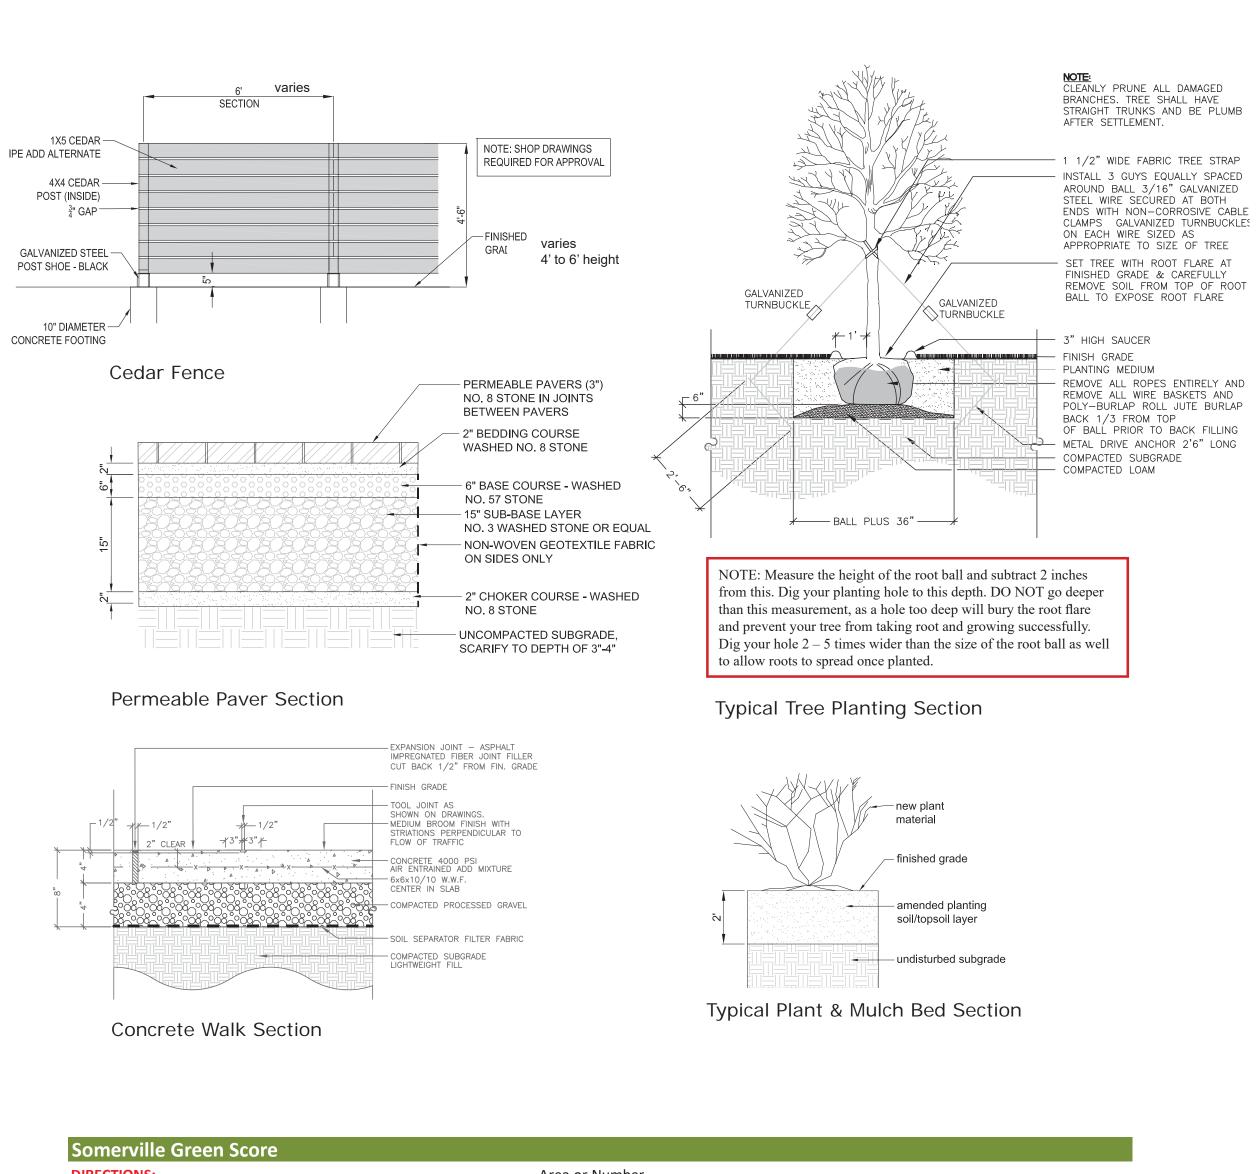

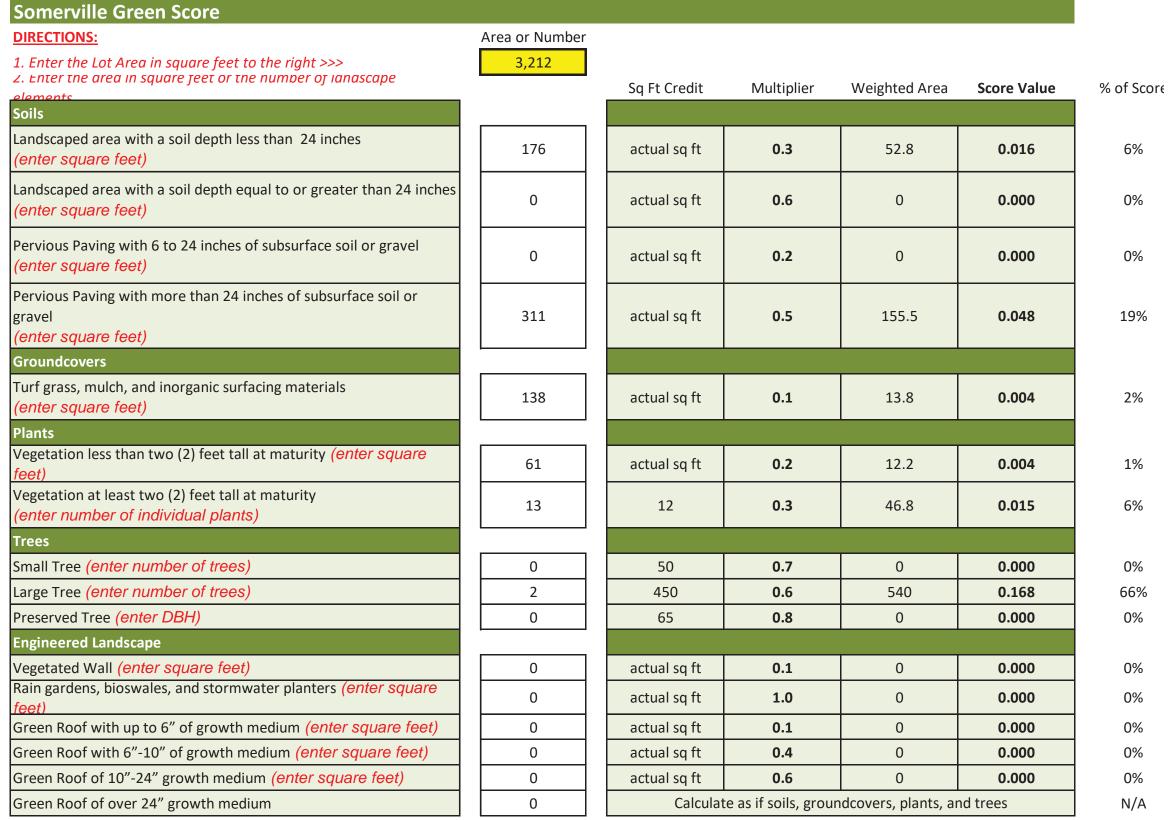

Green Score = 0.256



**Plant List NEW PLANTS Quantity Botanical Name Common Name** <u>Size</u> 1 Gallon 5 Calamagrostis x 'Karl Foerster' **Feather Reed Grass** Grows less than 2' + tall 5 Cornus x 'Ivory Halo' 7 Gallon Grows more than 2' + tall Ivory Halo Dogwood Liquidambar styraciflua 'Fastigiata' LARGE TREE B&B, Grows more than 30' + tall Fastigiate Sweetgum 2" caliper - 10' HT. Min. 300 Pachysandra terminalis In flats of 50 Grows less than 2' + tall Spurge








**GRO METAL EDGING SPECIFICATIONS** 

## **GRO METAL EDGING**

GRO Metal Edging is a strong yet lightweight, bendable restraint that provides a great finished look for both modular systems and/ or intensive and extensive layered green roof systems. Our "L shaped" design retains green roof planting materials and can be an edging detail for paver and tiles on rooftop walkways. GRO Metal Edging accommodates design curves and angles and is easy to install, making it a great alternative to structural curbing.



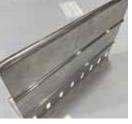

MATERIAL	Aluminum Extruded 6063 Alloy
DIMENSIONS	Varying heights 4.5", 6.5" & 8.25" height x 8' lengths
FINISH	Mill Finish Anodized Black DuraFlex available by special order
TEMP. DISPLACEMENT	Extruded aluminum is not impaired by exposure to low temperatures
UV RESISTANCE	Aluminum reflects ultraviolet radiation and is not damaged by harmful UV rays
COMBUSTIBILITY	Extruded aluminum will not burn, making it safer than many materials such as wood, paper, or plastic in design applications. Extruded aluminum also does not emit any toxic, hazardous fumes when exposed to high temperatures.



**GRO DRAIN COVERS AND LIDS SPECIFICATIONS** 


# **GRO DRAIN COVERS and LIDS**

GRO Drain Covers and Lids are lightweight for rooftop applications and provide a functional purpose with a polished look. They provide effective drainage of rainwater, retain green roof materials from entering the roof drains, and protect drains in the path of roof top walkways and decks. GRO Aluminum Drain Covers and Lids are designed to complement GRO Metal Edging in both modular and layered green roof applications. All aluminum GRO Drain Covers and Lids are from made recycled aluminum, are 100% recyclable, and may qualify for LEED points.



MATERIAL	Extruded 6063 Alloy Aluminum
DIMENSIONS	15" x 15" x 6" high (inside) Custom sizes available
FINISH	Mill finish anodized
UV PROTECTION	Reflects ultraviolet radiation
SECURITY	2 piece with lockable lid

www.greenrisetech.com info@greenrisetech.com

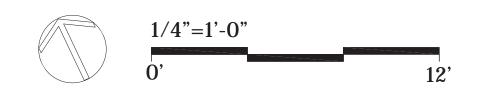



# Greenrise

# SPECIFICATIONS

### **GRO DRAIN MAT - 0.5"**

GRO Drain Mat 0.5" is a 1/2" thick drainage core with an extruded polymer matrix of tangled monofilaments, thermally bonded to a non-woven geotextile and molded into waffle patterns, for excellent compressive strength. The fleece is a lightweight non-woven, for excellent filtering performance, with high tensile and tear strength.



**GRO DRAIN MAT - 0.5"** 

#### DRAIN MAT SPECIFICATIONS

MATERIAL	Core: Extruded Polymer Fleece: Non-Woven Geotextile
ROLL DIMENSIONS	4' x 100' x 0.45" high; 400 ft²/roll & 48" diameter
ROLL WEIGHT	56 lbs/roll
COMPRESSIVE STRENGTH	>30,000 psf (ASTM D1621 modified & ASTM D4716) (flow rate may be decreased)

#### FLOW RATES: ASTM D4716

COMPRESSION APPLIED (psf)	1.0 GRADIENT	.04 GRADIENT	.02 GRADIENT
50			2.12 gpm/ft
100		2.05 gpm/ft	
250			1.95 gpm/ft
500	16.30 gpm/ft	2.20 gpm/ft	1.17 gpm/ft
1,000	13.72 gpm/ft	1.89 gpm/ft	.97 gpm/ft
2,000	6.81 gpm/ft	.67 gpm/ft	.35 gpm/ft
30,000			.10 gpm/ft*
	* 30,000 psi was applied applied to sample and A	for 1 hr. then able to relax fo STM D4716 was run. Passed.	or 24 hrs. before 1,000 psf was

#### FABRIC SPECIFICATIONS

TABILIC SI ECII ICATIONS		
	NON-WOVEN	<u>ASTM</u>
WEIGHT	.5 oz/ft²	D5261
PUNCTURE STRENGTH	250 lbs	D6241
AOS (MAX. AVERAGE)	70 US Sieve	D4751
PERMEABILITY	0.21 cm/sec	D4491

info@greenrisetech.com www.greenrisetech.com



S	TANDARD SEMPERGREEN SEDUM-MIX BLANKET		
	0 % biodegradable vegetation blanket produced	TECHNICAL DATA	
	n a coir mat, a Sempergreen® substrate mix and		
	plant mix consisting out 12 to 16 varieties of	Coverage:	85% - 95%
	cculents. Sempergreen® vegetation blankets are		
	oduced in accordance with FLL guidelines and	Weight dry:	Approx. 3½-4 lbs/sq.ft
A	NSI-SPRI compliant.	Weight saturated:	Approx. 4½ - 5 lbs/sq.ft
			Approx. 22-24 ½ kg/m²
•	Sedum spurius 'Fuldaglut'	Tensile strength:	N/A
•	Sedum spurius 'John Creech'		
•	Sedum spurius 'Red Carpet'	Thickness:	0.50 - 0.75 inch
•	Sedum kamtschaticum 'Variegatum'		(1.3 cm - 1.9 cm)
•	Sedum kamtschaticum		
•	Sedum kamtschaticum var. floriferum 'Weihenstephaner Gold'	Sq.ft per roll:	25 sq.ft (2.32257 m <sup>2</sup> )
•	Sedum takesimensis 'Golden Carpet'	Width roll:	Approx 47" (119.38 cm)
•	Sedum x Immergrunchen	Length roll:	Approx 77" (195.58 cm)
•	Sedum subsp. rupestre 'Angelina'		
•	Sedum subsp. rupestre 'Blue Spruce'	Square footage	
•	Sedum acre 'Aureum'	per pallet:	15-16 rolls per pallet space =
•	Sedum acre 'Goldmoss'		375-400 sft per pallet space
•	Sedum album 'Coral Carpet'		
•	Sedum album 'Murale'	Maximum square foot	age per truck: Approx 9000 sft
•	Sedum hispanicum		
•	Sedum sexangulare	Actual sft per truck d	epends on the moisture
•	Sedum stefco	content (=weight) at	the time of harvesting.

T: (540) 399-5055

F: (540) 399-9085

E: sales@moeringsusa.com

W: www.sempergreen.com



#### **GRO ROOT BARRIER 20 SPECIFICATIONS**

# **GRO ROOT BARRIER 20**

GRO Root Barrier is a smooth polyethylene geomembrane film that acts as a waterproof seal, protecting the soil from moisture loss, and redirects soil roots as needed. For use when a root barrier is required.



MATERIAL	Black Polyethylene Geomembrane
THICKNESS	20 mil *Other thicknesses available upon request
DIMENSIONS & WEIGHT	53" x 136' ; 600 ft²/roll ; 85 lbs/roll 53" x 175' ; 773 ft²/roll ; 96 lbs/roll
TENSILE STRENGTH @ BREAK	96 ppi (ASTM D6693)
ELONGATION @ BREAK	900% (ASTM D6693)
TEAR RESISTANCE	12 lbs (ASTM D1004)
PUNCTURE RESISTANCE	60 lbs (ASTM D4833)
CARBON BLACK CONTENT	2.4% (ASTM D4128)
OXIDATIVE INDUCTION TIME	100 mins (ASTM D3895)

# **Product Data Sheet** Protection Mat SSM 45



High quality recycled fiber mat made of polyester/polypropylene.

el fills, slab pavings, etc.

cled synthetic fibers, for the application as a protection layer under green roofs, grav-

Ř	inickness:	ca. U.Z In.	(ca. 5 mm)
	Weight:	ca. 0.1 lbs/sq. ft.	(ca. 470 g/
	Water retention capacity:	ca. 0.12 gal/sq. ft.	(ca. 5 l/m²)
	Strength class:	3	
	Don't at a company of the company of		

#### Protection efficiency according to EN ISO 13428: Residual thickness ≥ 40 %

Tensile strength lengthwise: Extension lengthwise:	> 31.4 lbs/in. > 75 %	(> 5.5 kN/m)
Dimensions:	ca. 6.6 ft. x 32.8 ft.	(ca. 2.00 m x 10.00 n
ca. 215 sq. ft. (ca. 20 m²), folde	ed	

brown mottled

- resistant to mechanical stress
- with proven protective effect according to European Standard EN ISO 13428
- water and nutrient retention non-rotting
- biologically neutral
- bitumen and polystyrene made of recycled fibers

quick and easy installation

#### allowance for overlap and wastage of ca. waterproofing or root barrier with an overlap 10–15 %. Protection Mat SSM 45 is, of 4 inch. The protection mat has to be taken included, but not limited to, to be installed according to manufacturer's instructions, not exposed to UV-light, completely covered. Call manufacturer for further options.

# **Health and Safety**

nstallation Instructions

Install the Protection Mat SSM 45 above a

above the Growing Media along edges and

at roof penetrations. Cut the protection mat

in situ at roof penetrations. Consider an

This product does not require a material safety data sheet (MSDS) according to the OSHA Hazard Communication Standard (29 CFR 1910.1200). When used as recommended or under ordinary

conditions, it should not present a health and safety hazard. However, an MSDS can be provided as a courtesy in response to a customer request.



**NOTE:** SEE PLAN A-102 FOR LAYOUT





Moerings USA, LLC

P.O. Box 60

Lignum, VA 22726

**PROJECT NAME** 

**PROJECT ADDRESS** 

CLIENT

ARCHITECT


**44 WHITE STREET** 


**RESIDENCES** 

44 WHITE STREET

SOMERVILLE, MA


**JACOB SIMMONS** 

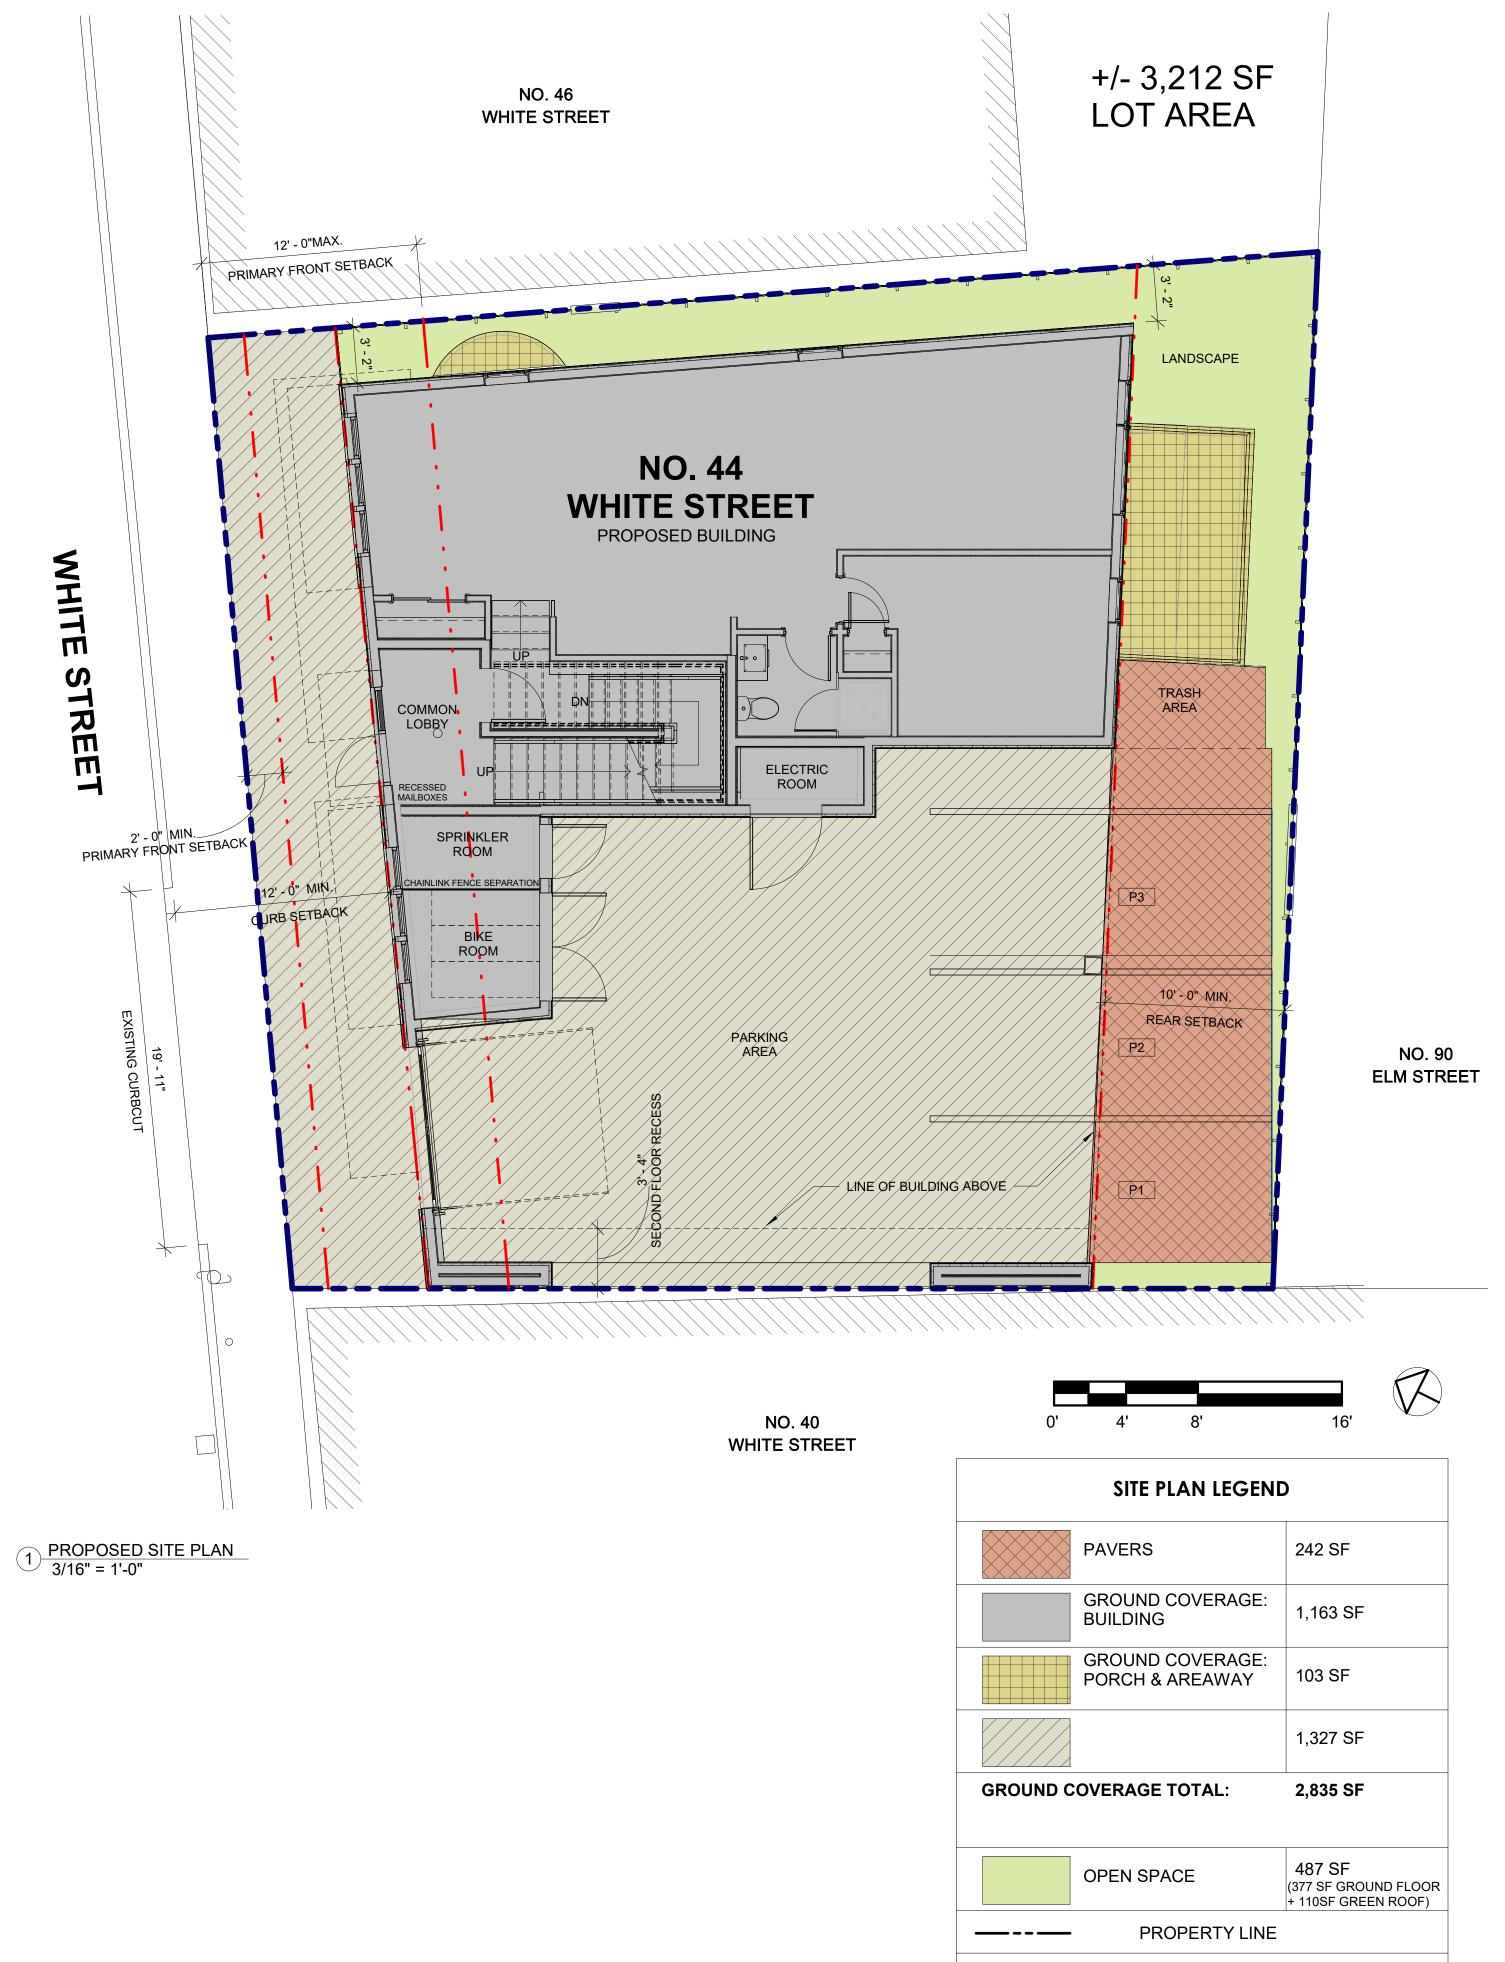

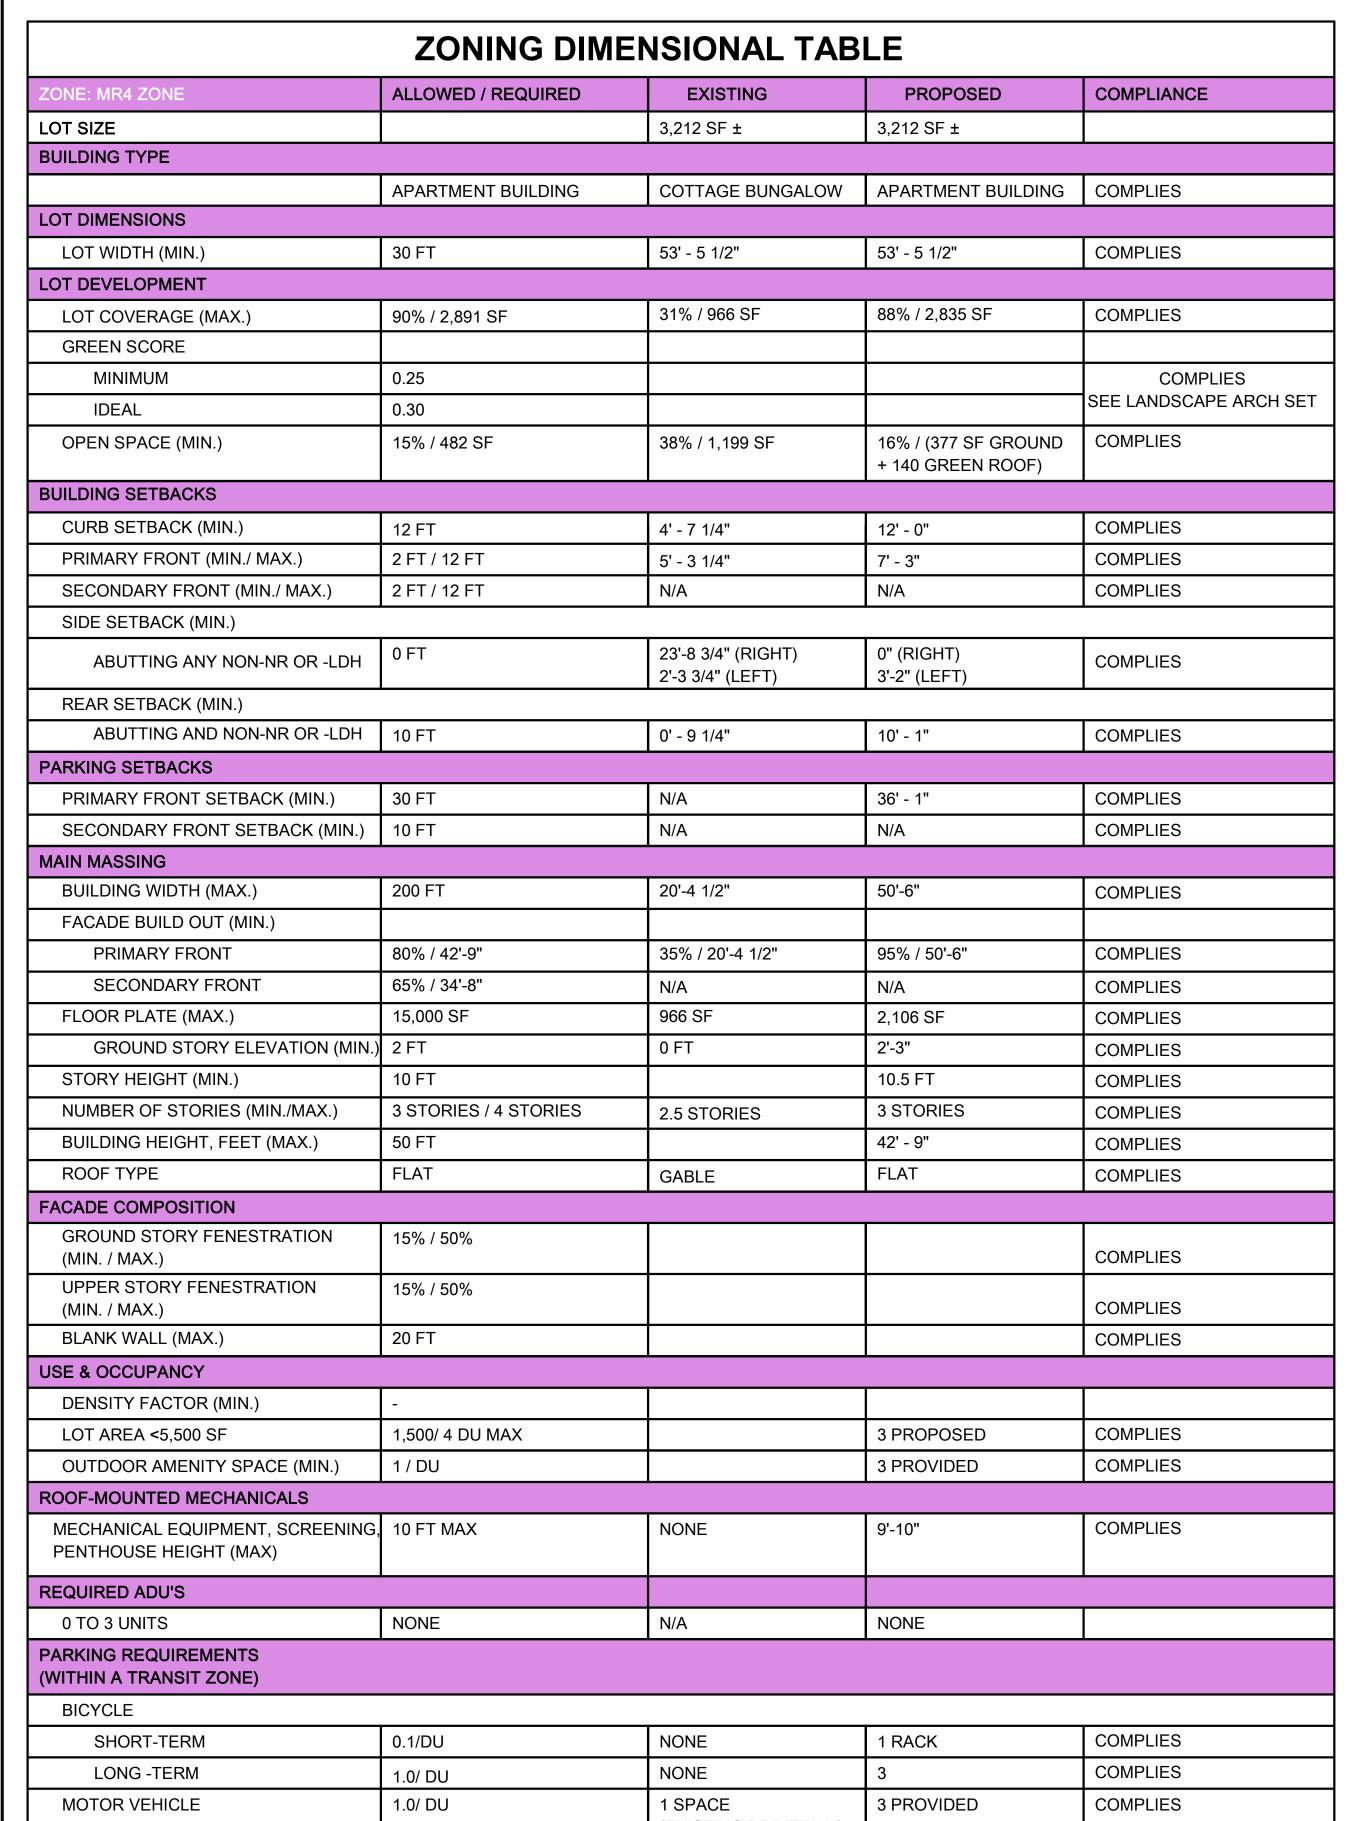

ZONE: MR4

PEDESTRIAN STREET: NO

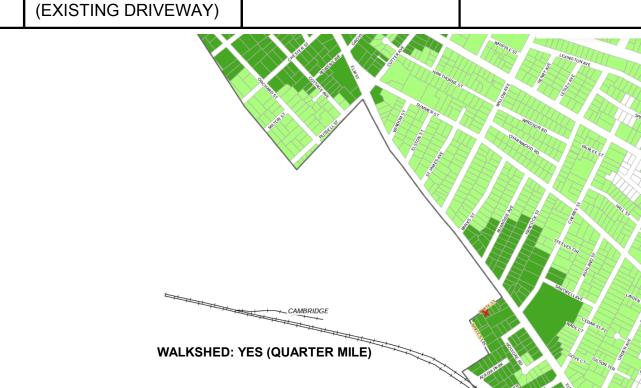



REQUIRED SETBACK LINE

THIS PLAN IS FOR INFORMATIONAL AND ILLUSTRATIVE PURPOSES ONLY. THE PREPARER OF THIS PLAN MAKES NO CLAIM TO ITS ACCURACY. THIS PLAN SHALL NOT BE USED OR RELIED UPON IN ANY CIRCUMSTANCE. A CERTIFIED LAND SURVEYOR SHALL PROVIDE AN OFFICIAL CERTIFIED PLOT PLAN. THE PURPOSE OF THIS PLAN IS TO ILLUSTRATE A POTENTIAL PROJECT BASED ON THE CURRENT ZONING PARAMETERS; VERIFICATION BY THE CITY OF SOMERVILLE IS REQUIRED.

24025

**TMC** 

Date

44 WHITE STREET RESIDENCES

SITE PLAN &

ZONING

PROJECT NAME

**44 WHITE STREET RESIDENCES** 

PROJECT ADDRESS

44 WHITE STREET, SOMERVILLE, MA

CLIENT

**JACOB SIMMONS** 

ARCHITECT



KHALSA DESIGN, INC. 17 IVALOO STREET SUITE 400 SOMERVILLE, MA 02143 TELEPHONE: 617-591-8682

CONSULTANTS:

COPYRIGHT KDI © 2025
THESE DRAWINGS ARE NOW AND DO
REMAIN THE SOLE PROPERTY OF KHALSA
DESIGN INC. USE OF THESE PLANS OR ANY
FORM OF REPRODUCTION OF THIS DESIGN
IN WHOLE OR IN PART WITHOUT EXPRESS
WRITTEN CONSENT IS PROHIBITED AND
SHALL RESULT IN THE FULLEST EXTENT
OF PROSECUTION UNDER LAW

REGISTRATION

Project number	24025
Date	03/25/2025
Drawn by	NB
Checked by	TMC
Scale	1/8" = 1'-0"
REVISIONS	

30ale 1/0 - I		
REVISIONS		
Description	Date	

AREA PLANS

A-021 44 WHITE STREET RESIDENCES

PROJECT NAME

**44 WHITE STREET RESIDENCES** 

PROJECT ADDRESS 44 WHITE STREET, SOMERVILLE, MA

CLIENT

**JACOB SIMMONS** 



ARCHITECTURE KHALSA DESIGN, INC. 17 IVALOO STREET SUITE 400 SOMERVILLE, MA 02143 TELEPHONE: 617-591-8682

CONSULTANTS:

COPYRIGHT KDI © 2025
THESE DRAWINGS ARE NOW AND DO
REMAIN THE SOLE PROPERTY OF KHALSA
DESIGN INC. USE OF THESE PLANS OR ANY
FORM OF REPRODUCTION OF THIS DESIGN
IN WHOLE OR IN PART WITHOUT EXPRESS
WRITTEN CONSENT IS PROHIBITED AND
SHALL RESULT IN THE FULLEST EXTENT
OF PROSECUTION UNDER LAW

Project number	2402
Date	03/25/202
Drawn by	NE
Checked by	TMC
Scale	1/4" = 1'-0
REVISIONS	

No.	Description	Date

BASEMENT & FIRST FLOOR PLAN

44 WHITE STREET RESIDENCES

**44 WHITE STREET RESIDENCES** 

PROJECT ADDRESS 44 WHITE STREET, SOMERVILLE, MA

**JACOB SIMMONS** 



ARCHITECTURE KHALSA DESIGN, INC. 17 IVALOO STREET SUITE 400 SOMERVILLE, MA 02143 TELEPHONE: 617-591-8682

COPYRIGHT KDI © 2025
THESE DRAWINGS ARE NOW AND DO
REMAIN THE SOLE PROPERTY OF KHALSA
DESIGN INC. USE OF THESE PLANS OR ANY
FORM OF REPRODUCTION OF THIS DESIGN IN WHOLE OR IN PART WITHOUT EXPRESS WRITTEN CONSENT IS PROHIBITED AND SHALL RESULT IN THE FULLEST EXTENT OF PROSECUTION UNDER LAW

Project	number	2402
Date	03	3/25/202
Drawn	by	N
Check	ed by	TM
Scale	1/	<mark>/4" = 1'-(</mark>
REVI	SIONS	
No.	Description	Date

SECOND & THIRD FLOOR PLAN

44 WHITE STREET RESIDENCES

**44 WHITE STREET RESIDENCES** 

PROJECT ADDRESS 44 WHITE STREET, SOMERVILLE, MA

**JACOB SIMMONS** 



ARCHITECTURE KHALSA DESIGN, INC. 17 IVALOO STREET SUITE 400 SOMERVILLE, MA 02143 TELEPHONE: 617-591-8682

COPYRIGHT KDI © 2025
THESE DRAWINGS ARE NOW AND DO
REMAIN THE SOLE PROPERTY OF KHALSA
DESIGN INC. USE OF THESE PLANS OR ANY
FORM OF REPRODUCTION OF THIS DESIGN
IN WHOLE OR IN PART WITHOUT EXPRESS
WRITTEN CONSENT IS PROHIBITED AND
SHALL RESULT IN THE FULLEST EXTENT
OF PROSECUTION UNDER LAW

Project number	2402
Date	03/25/202
Drawn by	N
Checked by	TM
Scale	1/4" = 1'-
REVISIONS	

No.	Description	Date

**ROOF PLAN** 

**A-102** 44 WHITE STREET RESIDENCES



T.O. HEADHOUSE 87' - 4" PARAPET 80' - 0" ROOF 77' - 6" 3RD FLOOR 67' - 0" 2ND FLOOR 56' - 6" 1ST FLOOR 46' - 0" GRADE 43' - 9"

PROJECT NAME

**44 WHITE STREET RESIDENCES** 

PROJECT ADDRESS

44 WHITE STREET, SOMERVILLE, MA

CLIENT

**JACOB SIMMONS** 

ARCHITECT



KHALSA DESIGN, INC. 17 IVALOO STREET SUITE 400 SOMERVILLE, MA 02143 TELEPHONE: 617-591-8682

CONSULTANTS:

COPYRIGHT KDI © 2025
THESE DRAWINGS ARE NOW AND DO
REMAIN THE SOLE PROPERTY OF KHALSA
DESIGN INC. USE OF THESE PLANS OR ANY
FORM OF REPRODUCTION OF THIS DESIGN
IN WHOLE OR IN PART WITHOUT EXPRESS
WRITTEN CONSENT IS PROHIBITED AND
SHALL PESULT IN THE FILLEST EXTENT SHALL RESULT IN THE FULLEST EXTENT

Project	t number	24025
Date_		03/25/2025
Drawn	by	NB
Checke	ed by	TMC
Scale		3/16" = 1'-0"
REVI	SIONS	
No.	Description	Date

**ELEVATIONS** 

**A-300** 44 WHITE STREET RESIDENCES












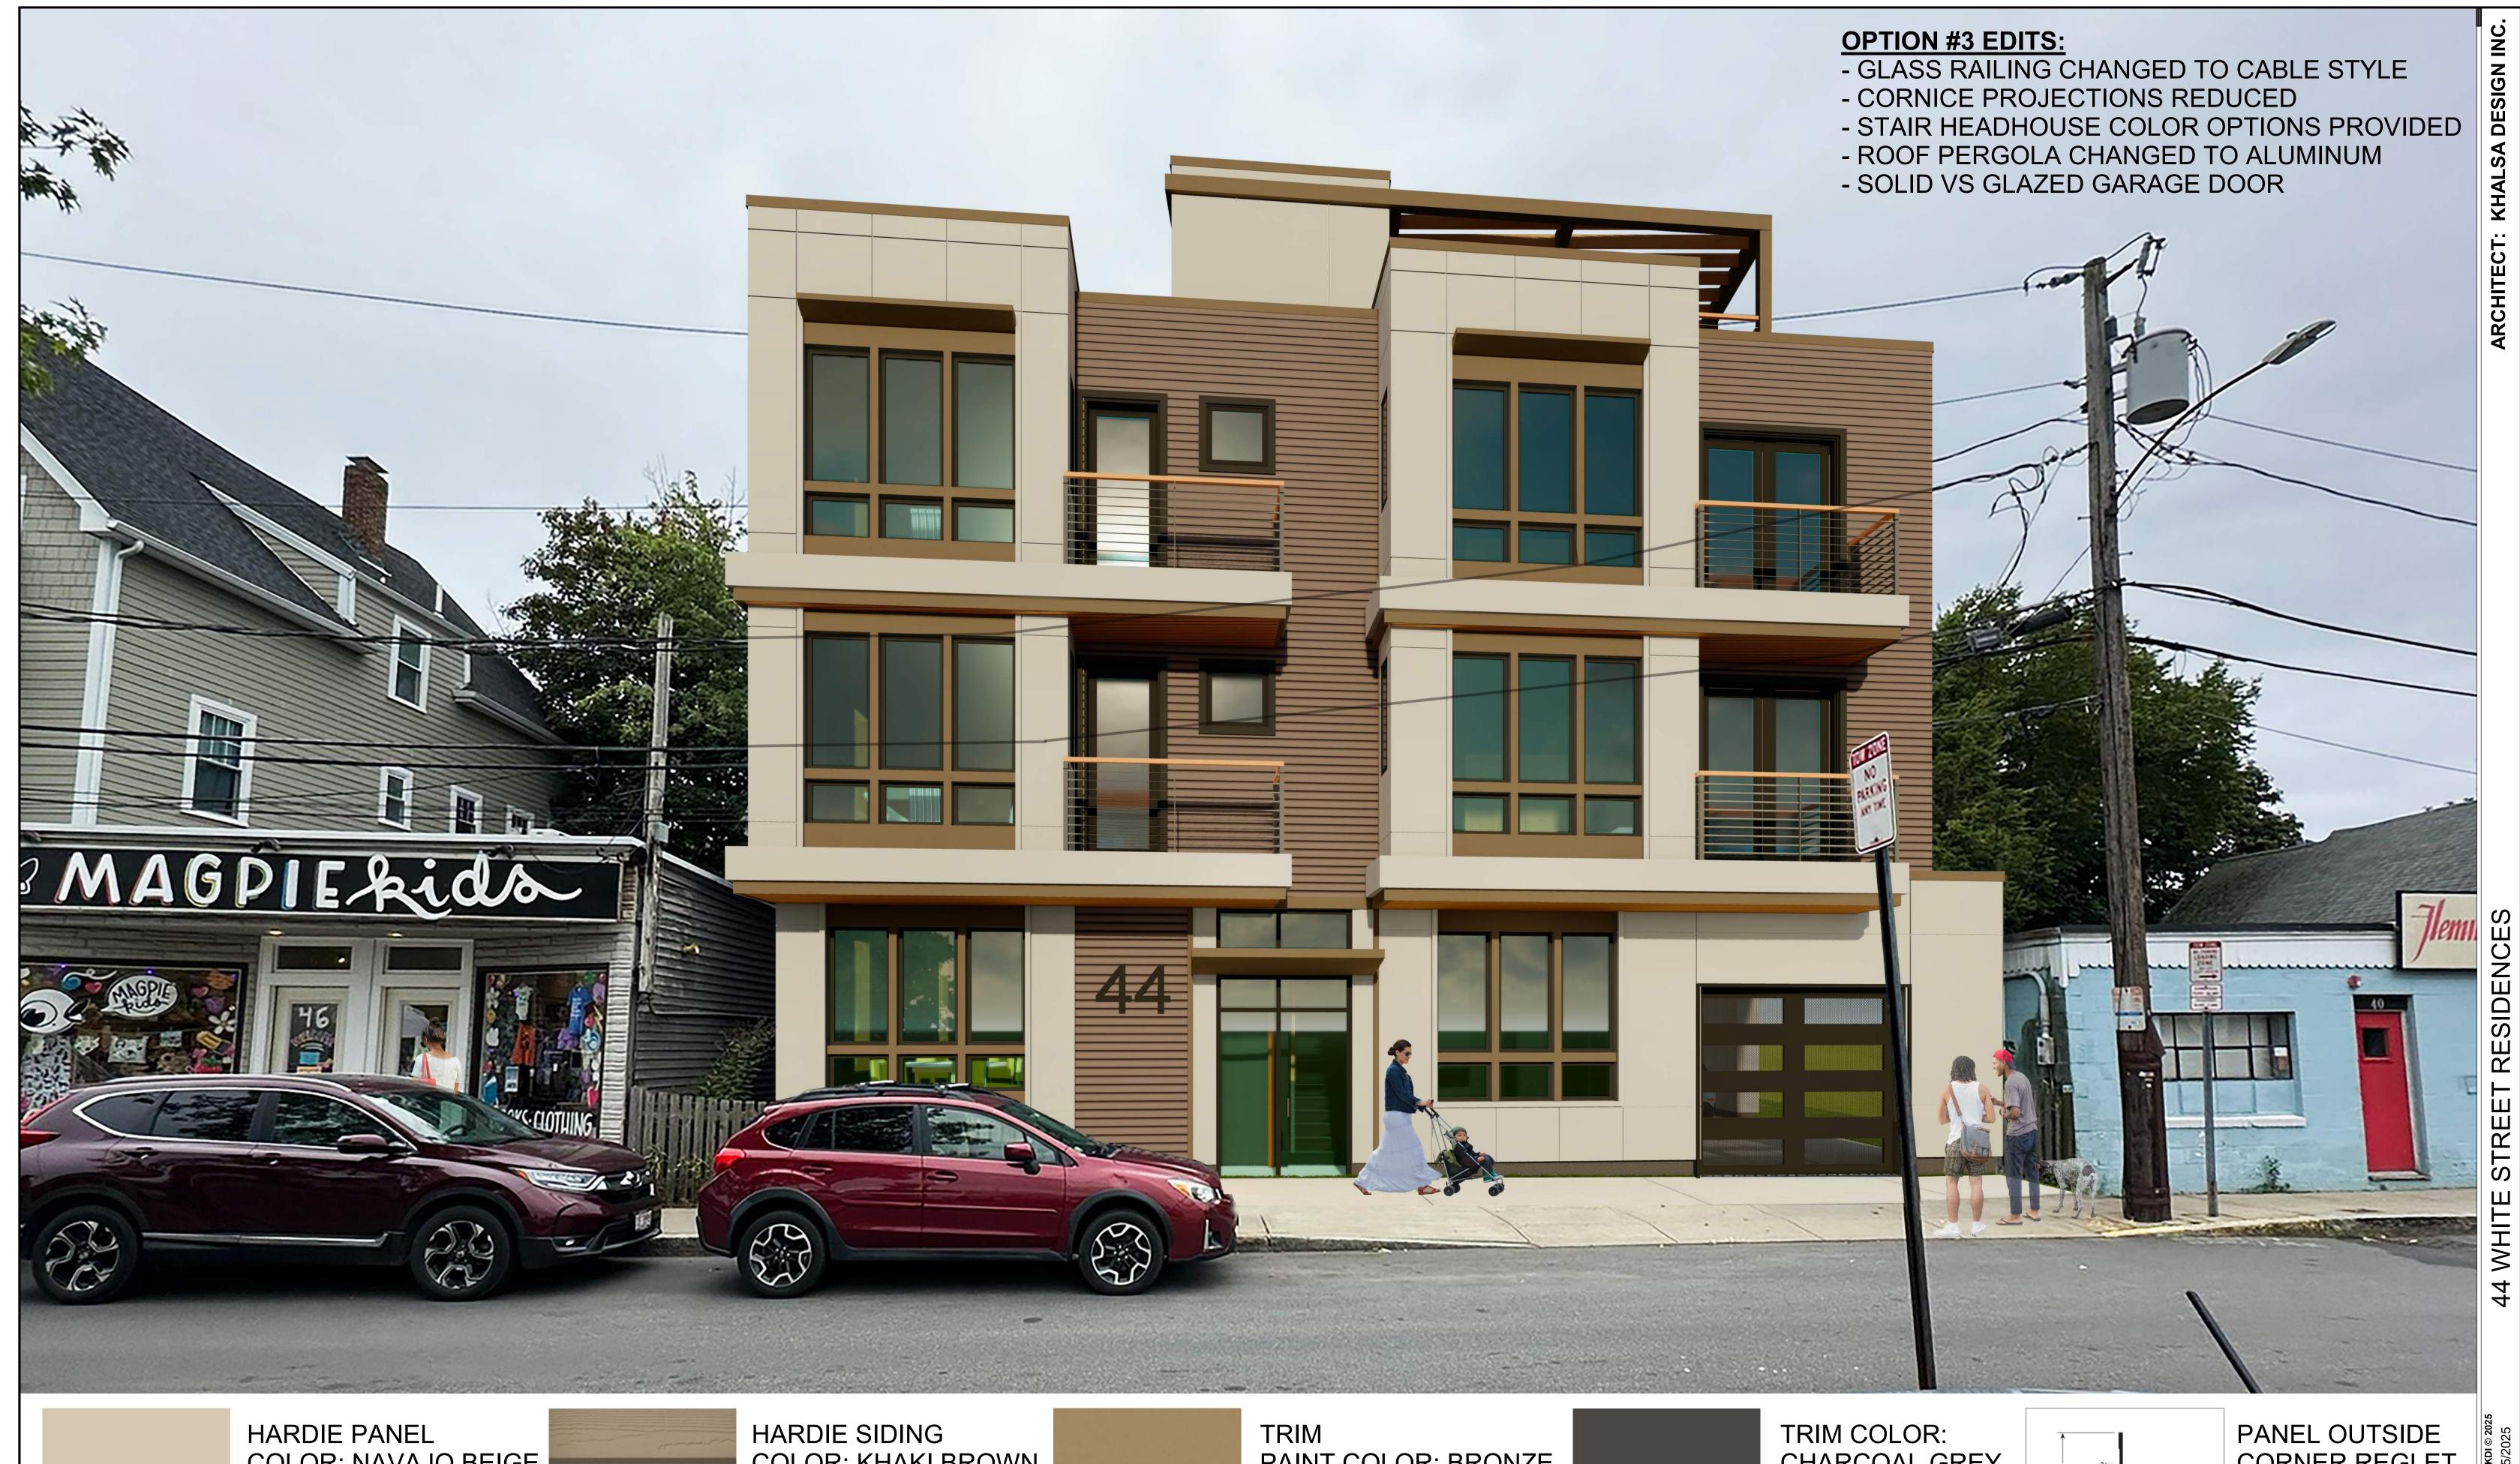

COLOR: NAVAJO BEIGE




COLOR: KHAKI BROWN **EXPOSURE: 6"** 



PAINT COLOR: BRONZE




CHARCOAL GREY

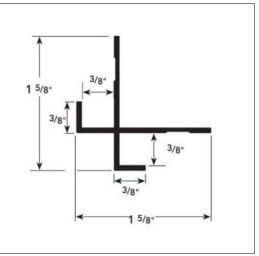

CORNER REGLET PROFILE



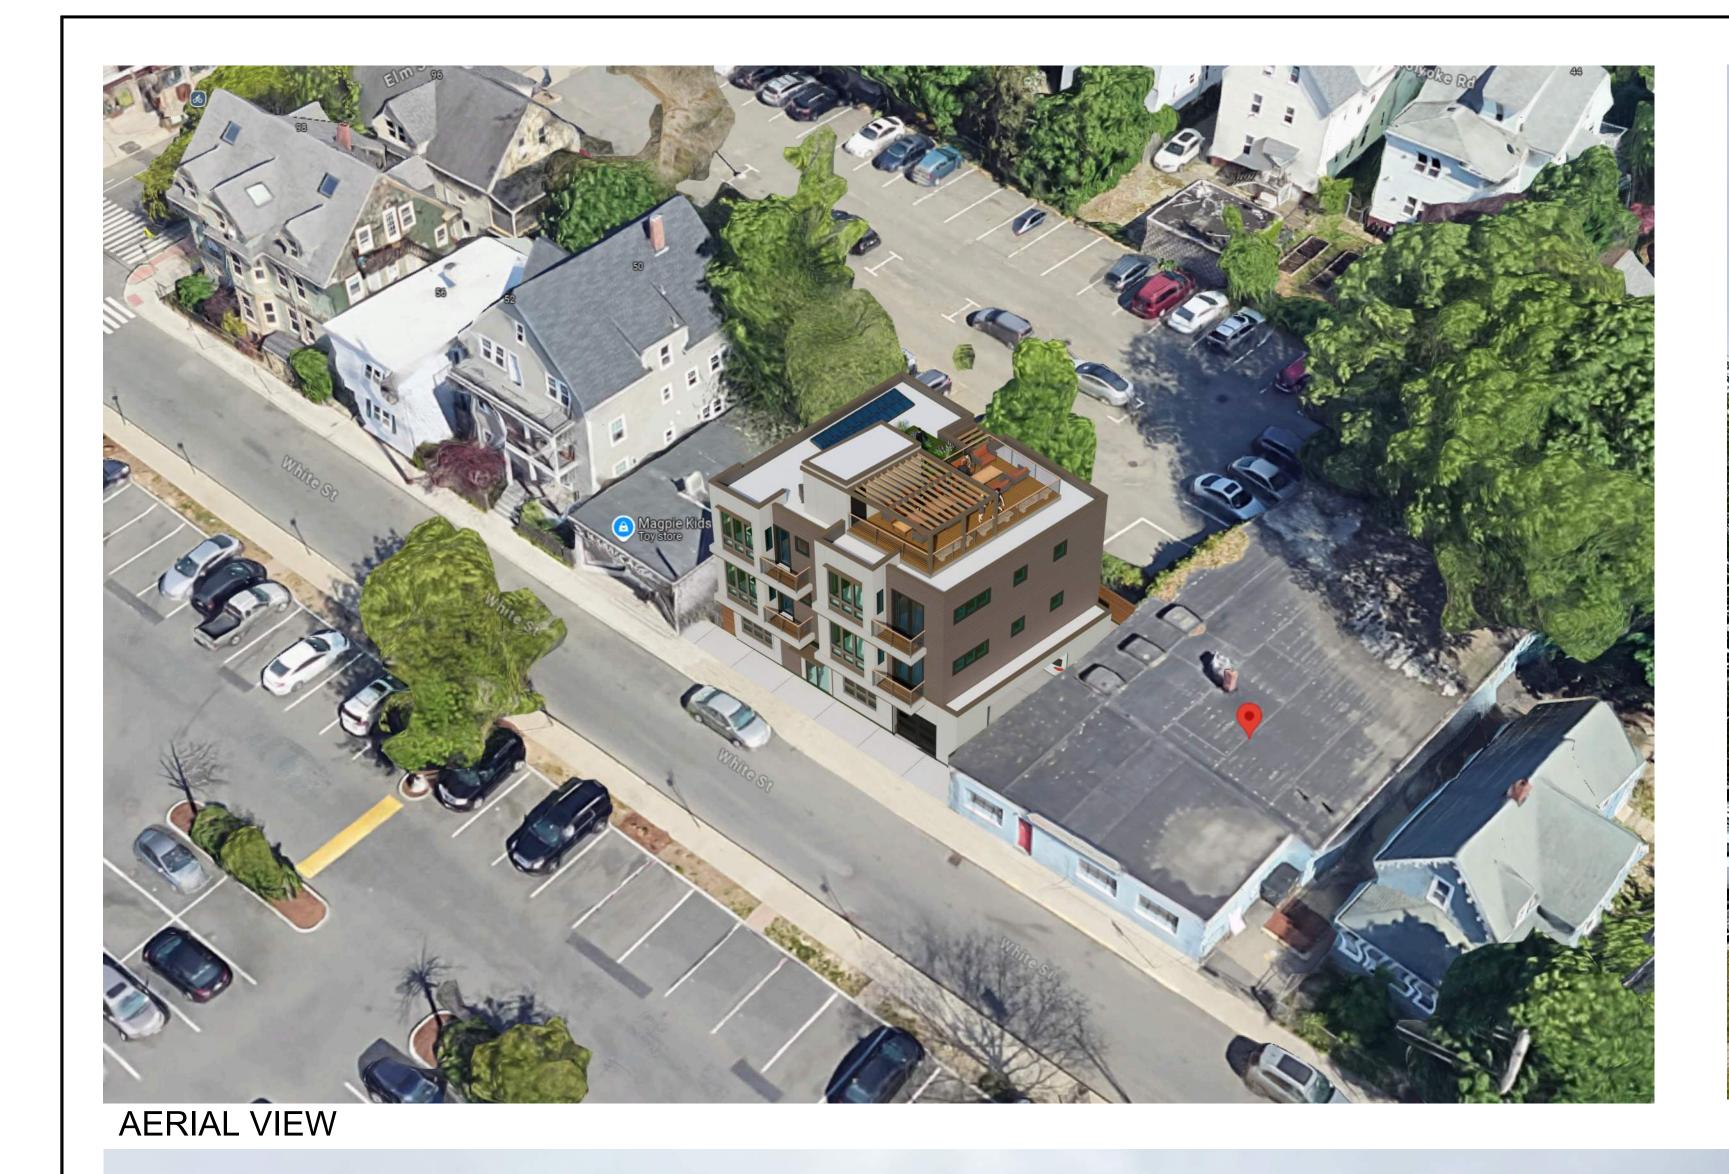

WHITE STREET VIEW



**REAR VIEW** 

FRONT VIEW - WHITE STREET



RENDERINGS




RSPECTIVE




2 STREET PERSPECTIVE 2

4 REAR PERSPECTIVE 2



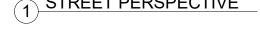




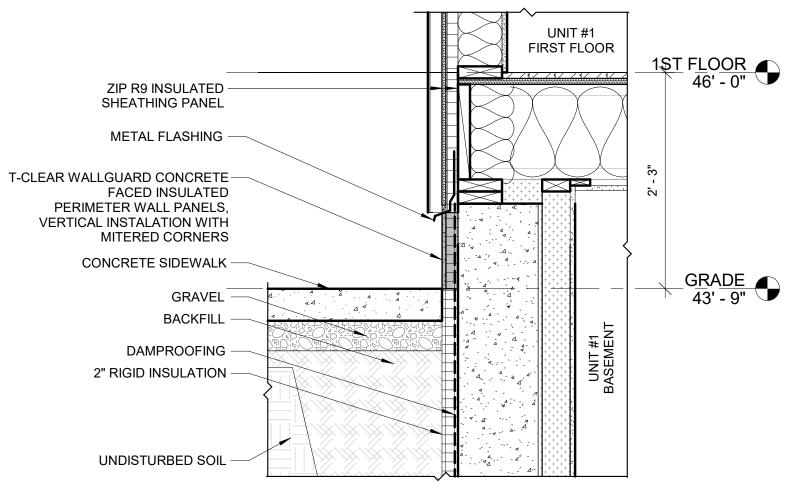

1" = 1'-0"





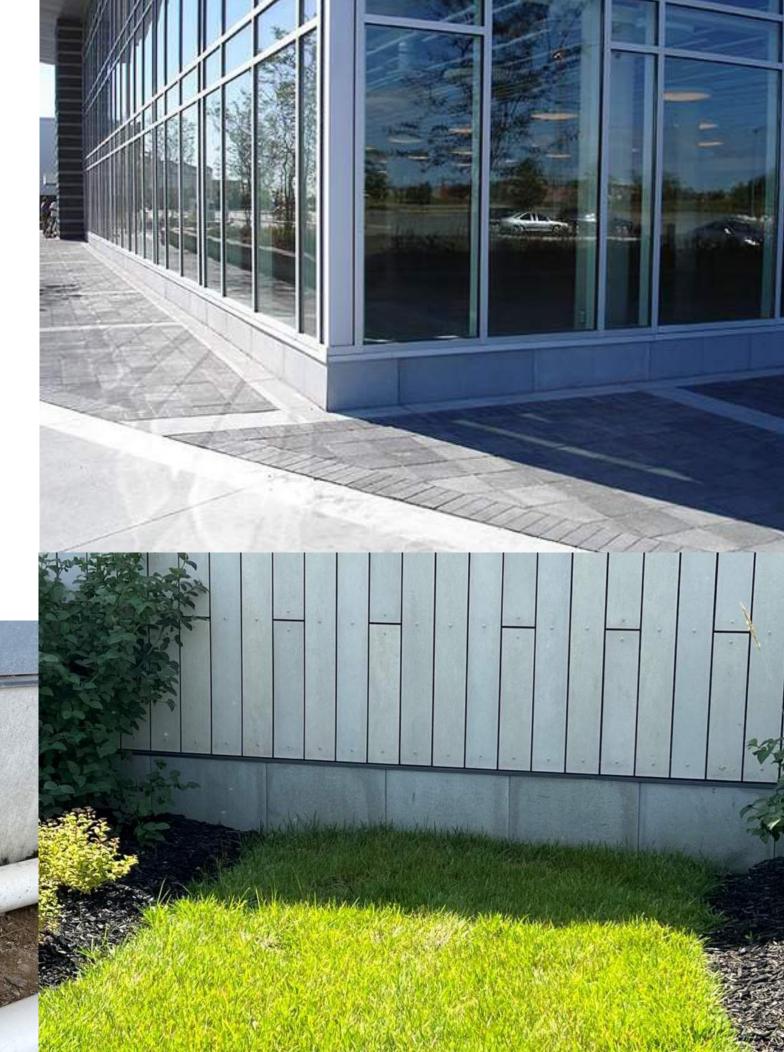

PARKING LOT

PARKING LOT

PROJECT NAME

44 WHITE STREET RESIDENCES

PROJECT ADDRESS

44 WHITE STREET, SOMERVILLE, MA

CLIENT

**JACOB SIMMONS** 

ARCHITECT



KHALSA DESIGN, INC.

17 IVALOO STREET SUITE 4

SOMERVILLE, MA 02143

TELEPHONE: 617-591-8682

CONSULTANTS:

COPYRIGHT KDI © 2025
THESE DRAWINGS ARE NOW AND DO
REMAIN THE SOLE PROPERTY OF KHALSA
DESIGN INC. USE OF THESE PLANS OR ANY
FORM OF REPRODUCTION OF THIS DESIGN
IN WHOLE OR IN PART WITHOUT EXPRESS
WRITTEN CONSENT IS PROHIBITED AND
SHALL RESULT IN THE FULLEST EXTENT
OF PROSECUTION UNDER LAW

REGISTRATION

Project n	umber	24025
Date		03/25/2025
Drawn by	1	Autho
Checked	by	Checke
Scale		1" = 40'-0
REVISI	ONS	
No.	Description	Date
		1

PROPOSED SHADOW STUDY

PARKING LOT

AV-8

44 WHITE STREET RESIDENCES

